


DRAWING LEGEND



- UNIT DESIGNATION **ROOM SQUARE** FOOTAGE, IF GIVEN ROOM NUMBER - LOCATION ON SHEET **DETAIL SECTION CALLOUT**

SHEET NUMBER LOCATION ON SHEET WALL SECTION CALLOUT SHEET NUMBER LOCATION ON SHEET

BUILDING SECTION CALLOUT SHEET NUMBER - LOCATION ON SHEET **ELEVATION CALLOUT** SHEET NUMBER

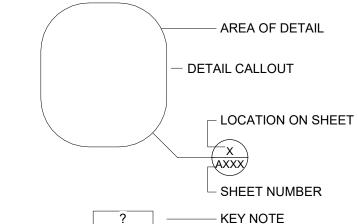

GENERAL NOTES

- TYPICAL DETAILS SHALL APPLY WHERE NO SPECIFIC DETAIL OR SECTIONS ARE GIVEN. THE CONTRACTOR SHALL VERIFY ALL DIMENSIONS, ELEVATIONS AND CONDITIONS PRIOR TO STARTING CONSTRUCTION.
- ANY DEVIATIONS FROM THE PLANS WHICH ARE NECESSITATED BY FIELD CONDITIONS, OR ANY CONDITIONS DIFFERENT FROM THOSE INDICATED ON PLANS, SHALL BE CALLED TO THE ATTENTION OF THE ARCHITECT, ALL WORK IS TO BE COORDINATED SO THAT
- ALL DIMENSIONS TO TAKE PRECEDENCE OVER SCALE SHOWN ON PLANS, ELEVATIONS, SECTIONS AND DETAILS. ALL LAYOUT WORK SHALL BE CHECKED FROM BOTH DIRECTIONS. DIMENSION STRINGS SHALL BE CLOSED.
- NOTES AND DETAILS ON DRAWINGS SHALL TAKE PRECEDENCE OVER TYPICAL DETAILS VERIFY ALL OPENINGS THROUGHOUT CONSTRUCTION WITH HEATING AND VENTILATION CONTRACTOR, PLUMBING CONTRACTOR AND ELECTRICAL CONTRACTOR FOR SIZE AND LOCATION. NOTIFY ARCHITECT OF ANY DEVIATIONS FROM THE DRAWINGS.
- SEE ARCHITECTURAL PLANS FOR SIZES AND LOCATIONS OF ALL DOOR AND WINDOW OPENINGS, LOCATIONS OF ALL NON BEARING PARTITIONS, CONCRETE SLABS, FLOOR AND ROOF SLOPES, DRAINS, ELEVATION. (LOCATION OF ALL STAIRWAYS, IF ANY) MISC. HANDRAILS, LADDERS, HANGERS, STEEL GRATING, LOCATION OF ALL CONCRETE INSERTS, GROOVES, CLIPS, GROUNDS, AND VENEER ANCHORS, LOCATION AND DETAIL OF MISC. YARD WORK INCLUDING WALKS, CURBS, DRIVEWAYS, TUNNELS, AND FINISHED
- FRAMING CONDITIONS NOT SPECIFICALLY SHOWN SHALL BE FRAMED SIMILAR TO OTHER DETAILS FOR THE RESPECTIVE MATERIAL.
- EACH TRADE SHALL INSPECT THE WORK UPON WHICH THEY WILL BE WORKING PRIOR TO THE START OF WORK. COMMENCEMENT OF THEIR WORK SHALL BE CONSTRUED AS ACCEPTANCE OF PRIOR WORK.
- IN THE EVENT OF DISCREPENCIES OF CONTRACT DRAWING SPECIFICATIONS, CLARIFICATION SHALL BE OBTAINED FROM THE ARCHITECT OR ENGINEER BEFORE
- ALL WORK SHALL BE CONSTRUCTED/INSTALLED/PLACED/ETC PLUMB/SQUARE/LEVEL/ETC. UNLESS OTHERWISE NOTED ON THE DRAWINGS OR IN THE SPECIFICATIONS MANUAL. ALL EQUIPMENT/ACCESSORIES/ETC. SHALL BE INSTALLED ACCORDING TO THE MANUFACTURER'S INSTALLATION INSTRUCTIONS UNLESS NOTED OTHERWISE ON THE DRAWINGS OR IN THE SPECIFICATION MANUAL.
- THE GENERAL CONTRACTOR SHALL PROVIDE DIRECT SUPERVISION OF ALL SUBCONTRACTORS TO ASSURE ACCURATE PLACEMENT OF REINFORCING STEEL EMBEDS, AND PROVISIONS FOR OTHER TRADES.
- PRODUCTS WHICH ARE SPECIFIED BUT ENGINEERED BY OTHERS SHALL BE DESIGNED IN ACCORDANCE WITH THE LATEST EDITION OF THE INTERNATIONAL BUILDING CODE, AND IN A MANNER CONSISTENT WITH THE QUALITY AND INTEGRITY OF INTENDED USE
- OPENINGS, POCKETS, ETC. SHALL NOT BE PLACED IN SLABS, DECKS, BEAMS, JOISTS, COLUMNS, WALLS, ETC. UNLESS SPECIFICALLY DETAILED ON THE STRUCTURAL

NORTH

Mountain Munchkins Addition Mountain Village, Colorado



Rachel M. Olson, AIA P.O. Box 4241 Durango, Colorado 81302 T 303.305.9342



DITION AD

HKINSE BLVD
D 81435

THESE DRAWINGS AND


SPECIFICATIONS SHALL REMAIN

THE PROPERTY OF THE ARCHITECT AND SHALL NOT BE

USED FOR ANY OTHER PROJECTS

WITHOUT THE WRITTEN CONSENT OF THE ARCHITECT.

- . THE CONTRACTOR SHALL VERIFY ALL DIMENSIONS, ELEVATIONS, AND CONDITIONS AND LOCATE ALL EXISTING UTILITY LINES PRIOR TO STARTING EXCAVATION. CONTRACTOR TO ESTABLISH A BENCHMARK TO BE USED AT A FUTURE DATE AND BE USED TO REFERENCE ELEVATIONS.
- 2. ANY DEVIATIONS FROM THE PLANS WHICH ARE NECESSITATED BY FIELD CONDITIONS, OR ANY CONDITIONS DIFFERENT FROM THOSE INDICATED ON PLANS. SHALL BE CALLED TO THE ATTENTION OF THE ARCHITECT. ALL WORK IS TO BE COORDINATED SO THAT COOPERATION BETWEEN TRADES, WHERE REQUIRED. IS ACCOMPLISHED.
- 3 . IN THE EVENT OF DISCREPANCIES OF CONTRACT DRAWINGS OR SPECIFICATIONS TO ACTUAL FIELD CONDITIONS, CLARIFICATION SHALL BE OBTAINED FROM THE ARCHITECT BEFORE PROCEEDING WITH THE WORK. THE ARCHITECT WILL NOT BE RESPONSIBLE FOR ANY WORK CONSTRUCTED WHERE A DISCREPANCY WAS DISCOVERED IN THE FIELD AND CONSTRUCTION WAS PERFORMED WITHOUT CLARIFICATION OR CORRECTION BY THE ARCHITECT.
- 4. THE GENERAL CONTRACTOR SHALL PROVIDE DIRECT SUPERVISION OF ALL SUBCONTRACTORS TO ASSURE ACCURATE PLACEMENT OF ANY NEW UTILITY TRENCHES AND UTILITY LINES ACCORDING TO THE GRADING AND SITE PLAN AND PER UTILITY COMPANY'S SPECIFICATIONS FOR CORRECT SEPARATION AND EMBEDMENT OF UTILITY LINES IN SAND, GRAVEL, OR OTHER SPECIFIED MATERIALS. ALL UTILITY LINES SHALL BE BACKFILLED AND COMPACTED AND ALL LINES TO BE MARKED WITH THE APPROPRIATE UTILITY TAPE BURIED IN THE
- 5. THE OWNER/CONTRACTOR SHALL TAKE ALL RESPONSIBILITY FOR COMPACTION. FILL SPECIFICATIONS AND TESTING. ANY SETTLEMENT PROBLEMS SHALL BE THE SOLE RESPONSIBILITY OF THE OWNER/CONTRACTOR.
- 6. ALL FINISH GRADE (F.G.) ELEVATIONS ARE APPROXIMATE 7 . A GEO-TECHNICAL SOILS REPORT WAS NOT PROVIDED FOR THIS PROJECT. THE OWNER AND CONTRACTOR ARE RESPONSIBLE FOR ALL SUB-SURFACE SOIL

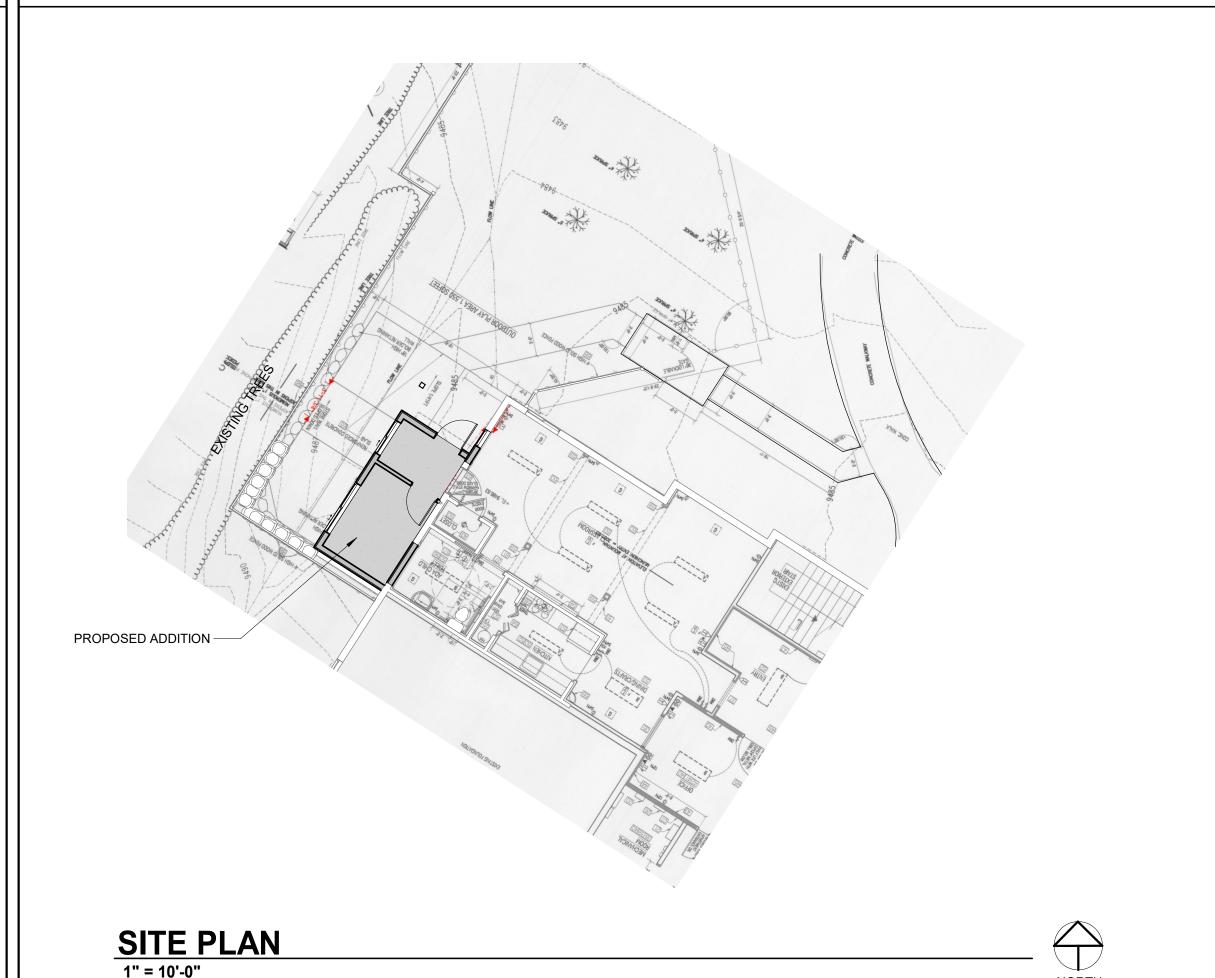

PROJECT DATA PROJECT NAME MOUNTAIN MUNCHKINS ADDITION

PROJECT ADDRESS 415 MOUNTAIN VILLAGE BLVD MOUNTAIN VILLAGE, COLORADO 81435

PROJECT OFFICE ADDITION TO EXISTING BUILDING.

DESCRIPTION ARCHITECT


OLSON ARCHITECTS, LLC RACHEL M. OLSON - AIA

P.O. BOX 4241 DURANGO, CO 81302

BUILDING REVIEW 2018 IBC CRITERIA

BUILDING AREA ADDITION = 140 SQ FT

VICINITY MAP

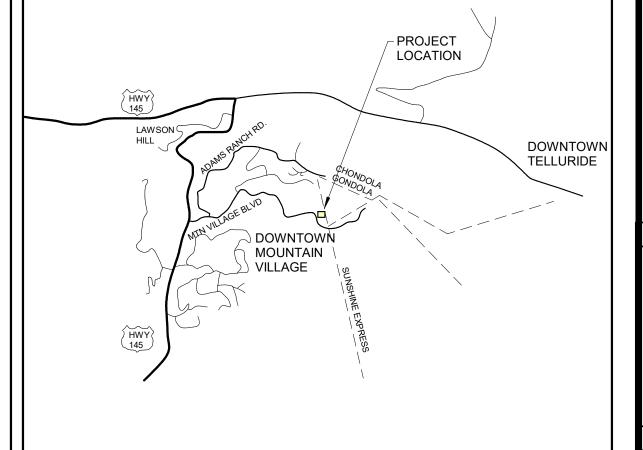

#	NAME
GENERA	L
G1.01	COVER SHEET
ARCHITE	
	CTURAL PROPOSED PLANS
ARCHITE A1.01 A2.01	

PROJ MGR PRINCIPAL DRAWING TITLE

COVER SHEET

WINDOW SCHEDULE

ı		SIZE		ROOM				
ı	WIN#	WIDTH	HEIGHT	#	NAME	OPERATION	HD HEIGHT	COMMENTS
ı	W01	4' - 0"	4' - 0"	101	FOYER	SL	7'-0"	
ı	W02	6' - 0"	2' - 0"	102	OFFICE	SL	7'-0"	
	W03	2' - 0"	4' - 0"			CS	MATCH EXISTING	VERIFY FINAL SIZE IN FIELD

NOTES

1. VERIFY ALL ROUGH OPENINGS WITH WINDOW MANUFACTURER PRIOR TO FRAMING.

- 2 . PROVIDE HIGH ALTITUDE INSULATED GLASS.
- PROVIDE HIGH ALTITUDE INSULATED GLASS.
 PROVIDE INSECT SCREENS FOR ALL OPERATING WINDOWS.
- 4. CONTRACTOR TO VERIFY REQUIRED QUANTITIES OF WINDOWS.
- 5 . ALL DIMENSIONS ARE NOMINAL. FIELD VERIFY ALL DIMENSIONS PRIOR TO PLACING ORDER FOR WINDOWS.
 6 . CONTRACTOR SHALL VERIFY AND PROVIDE TEMPERED GLAZING IN ALL REQUIRED LOCATIONS PER SECTION 2406 OF THE 2018 IBC / R308 OF 2018 IRC.
- 7 . U.N.O. WINDOW FRAMING TO MATCH EXISTING
 8 . ALL WINDOWS TO BE INSTALLED USING 'EBBA' WATER MANAGEMENT STRATEGIES.

DOOR SCHEDULE

	<u> </u>								
		SIZE		ROOM		FINISH			
DR#	STYLE	WIDTH	HEIGHT	#	NAME	INT	EXT	HARDWARE	COMMENTS
D101	HINGED	3' - 0"	6' - 8"	101	FOYER	MATCH EXISTING	MATCH EXISTING	MATCH EXISTING	
D102	HINGED	3' - 0"	6' - 8"	102	OFFICE	MATCH EXISTING	MATCH EXISTING	MATCH EXISTING	

OTES:

- 1. VERIFY ALL ROUGH OPENING SIZES WITH DOOR MANUFACTURER PRIOR TO FRAMING.
- 2. DOOR STYLE TO BE SELECTED BY OWNER.
- 3. CONTRACTOR TO LOCATE/VERIFY ALL TEMPERED GLAZING AS MAY BE REQUIRED BY OWNER AND PROVIDE AS PER SECTION 2406 OF THE 2018 IBC.

FLOOR PLAN NOTES


- . ALL EXTERIOR WALLS TO BE OF 2X6 @ 16" O.C. NOMINAL CONSTRUCTION, UNLESS OTHERWISE NOTED. ALL INTERIOR WALLS TO BE OF 2X4 @ 16" O.C. CONSTRUCTION, UNLESS OTHERWISE NOTED.
- 2. GENERAL CONTRACTOR TO COORDINATE WITH OWNER FOR ALL INTERIOR
- INTERIOR TRIM PACKAGE (i.e. BASE, CASE, ETC.) TO BE DETERMINED.
 ANY DISCREPANCIES WITH DIMENSIONS TO BE REPORTED TO ARCHITECT PRIOR TO CONSTRUCTION. IF CONTRACTOR, OWNER, OR SUBCONTRACTOR PROCEEDS WITH CONSTRUCTION WITHOUT ARCHITECT APPROVAL THEN THE ARCHITECT IS NOT RESPONSIBLE FOR THAT PART OF THE WORK.
- 5. PROVIDE MINIMUM INSULATION AT BUILDING ENVELOPE AS FOLLOWS: WALLS R20 MIN + R3.8 CONTINUOUS INSULATION., ROOFS R49 MIN. (OR AS NOTED ON DRAWINGS.), STEMWALL R13 MIN.
- 6. DIMENSION SYSTEM NOTE:ALL DIMENSIONS ARE FACE OF FRAMING TO FACE OF FRAMING OR FACE OF FRAMING TO CENTERLINE, U.N.O.

ROOF PLAN NOTES

- ROOF SLOPE SHALL MATCH EXISTING ROOF SLOPE.

 ALL ROOF PENETRATIONS ARE TO BE FLASHED PER ROOFING SYSTEM

 AND LEAST UP TO BE FLOW A TO BE FL
- MANUFACTURER'S RECOMMENDATIONS.
- ${\bf 3}$. ALL FLASHING USED SHALL BE MIN. 24GA. GALV.
- 4 . PROVIDE AND INSTALL 2-COURSES ICE & WATER SHIELD MEMBRANE @ EAVES AND VALLEYS AND 1-LAYER ON REMAINDER OF ROOF. ICE & WATER SHIELD TO WRAP SUB-FASCIA. FINISHED ROOF TO BE INSTALLED WITHIN 30 DAYS OF THE INSTALLATION OF THE ICE & WATER SHIELD.
- 5 . INSTALL ALL ROOFING MATERIALS PER MANUFACTURER'S INSTALLATION INSTRUCTIONS. PROVIDE ALL REQUIRED UNDERLAYMENTS AND ADDITIONAL MATERIALS FOR A COMPLETE AND THOROUGH INSTALLATION.

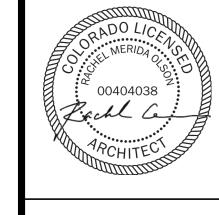

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OUTLINE OF WALLS
BELOW NEW DOWNSPOUT TO MATCH EXISTING 8' - 4 1/2" WINDOW TO BE -DEMOLISHED NEW GUTTER TO MATCH EXISTING GC TO EXTEND EXISTING FIRE SPRINKLER SYSTEM TO NEW ROOMS, VIF **ADA RR** DEMOLISH PORTION OF - RELOCATE VENT EXISTING SLAB ON GRADE OFFICE 102 CAP EXISTING SIDING TO -BE REMOVED & REPLACED WITH DRYWALL 3 1/2" / 12" DEMOLISH EXISTING POSTS & HANDRAILS SLOPE, VIF

CC TO EXTEND FUSTING
FIRE SPRINKLES SYSTEM
TO NEW MCOMS, VIF

DEMOLISH EXISTING
FIRE PRINKERS SYSTEM
TO REW MCOMS, VIF

DEMOLISH EXISTING
FIRE PRINKERS SYSTEM
TO REW MCOMS, VIF

DEMOLISH EXISTING
DEMOLISH EXISTING
FIRE PRINKERS TO NISTALL

RELOCATE VENT

DEMOLISH EXISTING
FIRE PRINKERS

DEMOLISH EXISTING
FIRE PRINCE

RELOCATE VENT

RELOCATE VENT

DEMOLISH EXISTING
FIRE PRINCE

RELOCATE VENT

RELOCATE VEN

ROOF PLAN1/4" = 1'-0"

DEMOLITION PLAN

1/4" = 1'-0"



PROPOSED FLOOR PLAN



MOUNTAIN VI
PROJECT NO: 003-202

ADDITION

SPECIFICATIONS SHALL REMAIN
THE PROPERTY OF THE
ARCHITECT AND SHALL NOT BE
USED FOR ANY OTHER PROJECTS
WITHOUT THE WRITTEN CONSENT
OF THE ARCHITECT.

APPROVALS

APPROVALS

PROJ MGR

RMO

PRINCIPAL

DRAWING TITLE

SHEET NO.

PROPOSED PLANS

A1.01
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